
novak+middleton WBBC

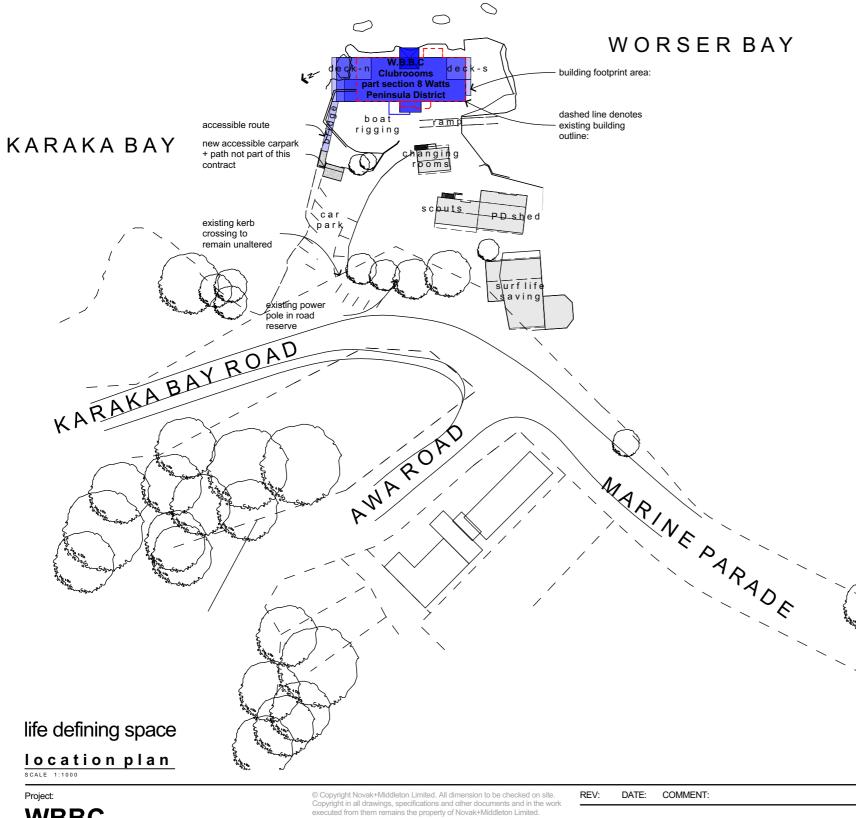

WBBC

For: WORSER BAY BOATING CLUB

At: Marine Parade, Seatoun, Wellington

Novak+Middleton Limited, 15 Everton Terrace, PO Box 12 232, Wellington 6144 t 04 472 9729 f 04 472 9728 e architects@novakmiddleton.co.nz iddleton.co.nz

Scale: 1:100 Drawing: Original size: A3 cover Date: 20 December 2016 Issue: File Reference: N:\2013\1345 Wor WBBC v20.pln **Building Consent Set**

SUMMARY

project address: 202 Marine Pa Wellington

lot: Part Section 8 Watts Peninsular Di more or less

resource consent: refer SR 364

zoning: open space b note: includes encroachment into coasta

wind zone: extra high as per engine

earthquake zone: zone 3

exposure zone: sea spray

total built area: existing boat club ground floor - boat store: 335m² first floor - clubrooms: 210.5m² decks: 22.6m² + 137.4m² + 13m² = 173 site coverage: building footprint 348.1m² >1m) = 380.5m²

new boat club (above 1m) =m²

ground floor: 414.4m² first floor: 334m² mezzanine floor: 28.6m² decks: 37.3m² (south) + 79.7m² (north) bridge area: 22.9m² site coverage: building footprint incl decl $1m = 457m^2 + entry roof eaves > 1m 9$ $1m 22.9m^2 = 489.3m^2$

change rooms, PD shed + surf life savin site coverage: 540m² (approx)

overall site coverage = 27.3% (approx)

max building height: refer SR

car parking: 1no. accessible car-p

kerb crossing: 1no. existing kerb


		WBBC drawing list
	ID	name
arade, Seatoun,	003	existing survey
	A001	cover
Viatriat 2 760ma2	A002	site works plan
District 3,769m ²	A101	ground floor plan - existing
	A102	first floor plan - existing
64 448	A103	ground floor plan
J+ ++0	A104	first floor plan
	A105	mezzanine floor plan
tal marine area	A106	roof plan
	A107	foundation plan
neer's calculations	A108	first floor framing plan
	A109	mezzanine floor framing plan
	A110	canopy roof
	A111	roof framing
	A112	ground + mezzanine floor bracing
	A113	first floor bracing
	A114	first floor ceiling plan
	A115	Deck Drainage
	A201	section a
3m²	A202	section b
n ² + 32.4m ² (decks	A203	section 1
· ·	A204	section 2
	A205	ramp/ bridge structure
	A301	north elevation
	A302	east elevation
	A303	south elevation
	A304	west elevation
	A401	door schedule
	A402	door schedule
cks/ stairs/ eaves >	A403	window schedule
9.4m² + bridge >	A404	window schedule
	A501	details
na	A502	
ng	A503	details
	A504	details
)	A505	details
	A506	details
R 364 448	A507	details
park	A508	details
park	A601	
b crossing	A602	
}	A603	kitchenette stair 01
the form and	A604 A605	stair 01
	A605 A606	womens/ mens WC
	A606 A607	womens/ mens WC
	A007	


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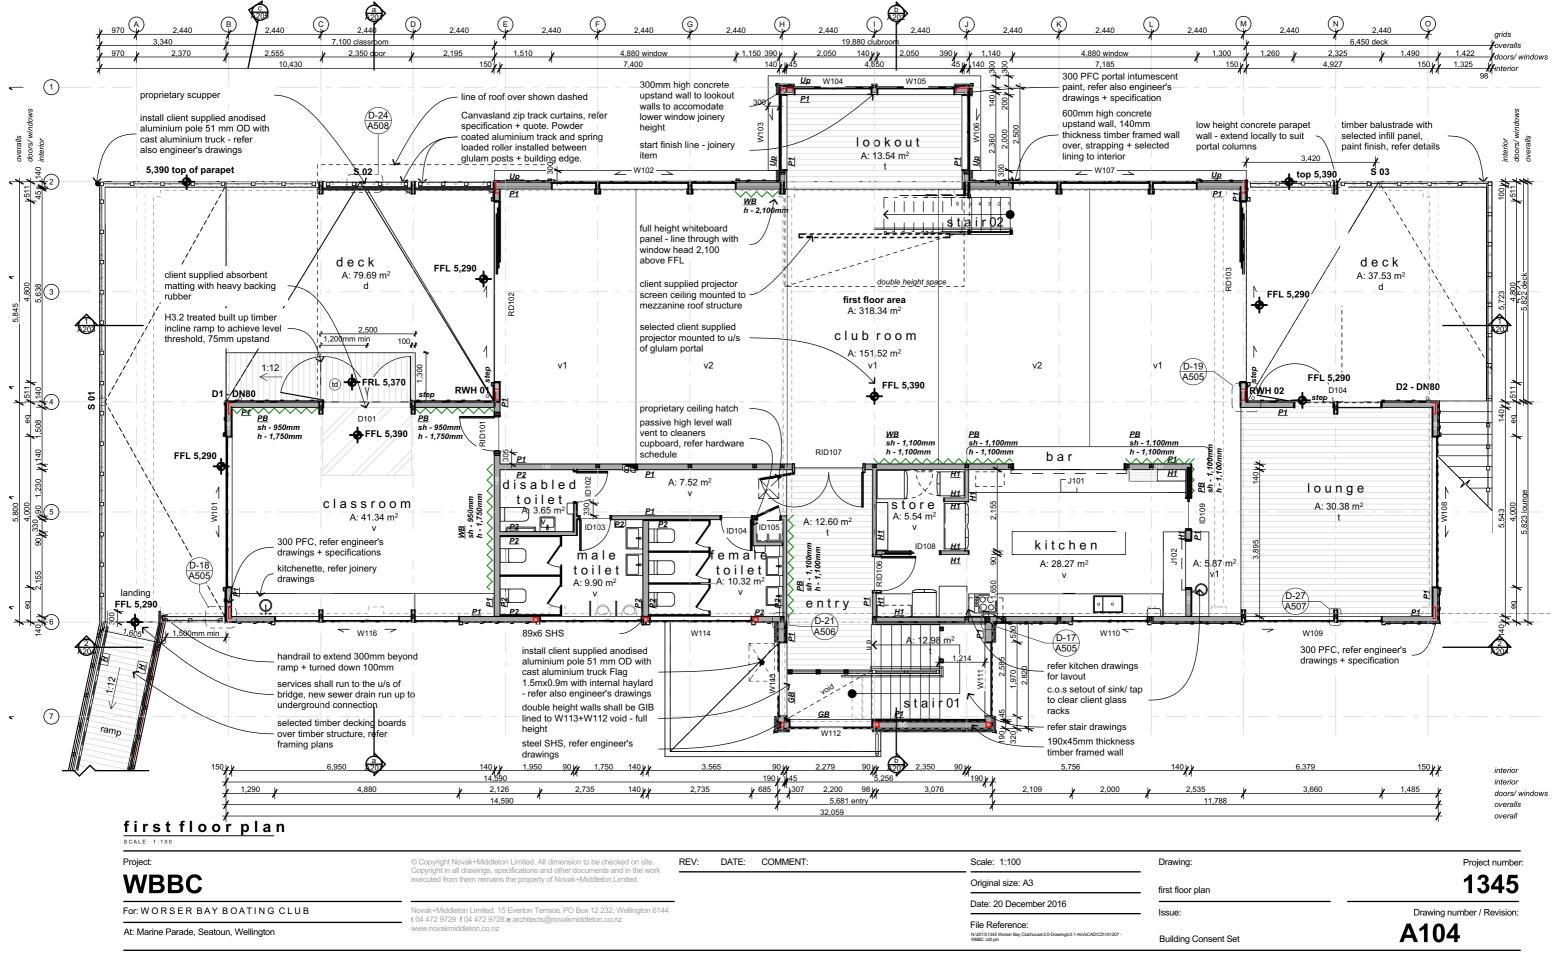
1345

Drawing number / Revision


A001



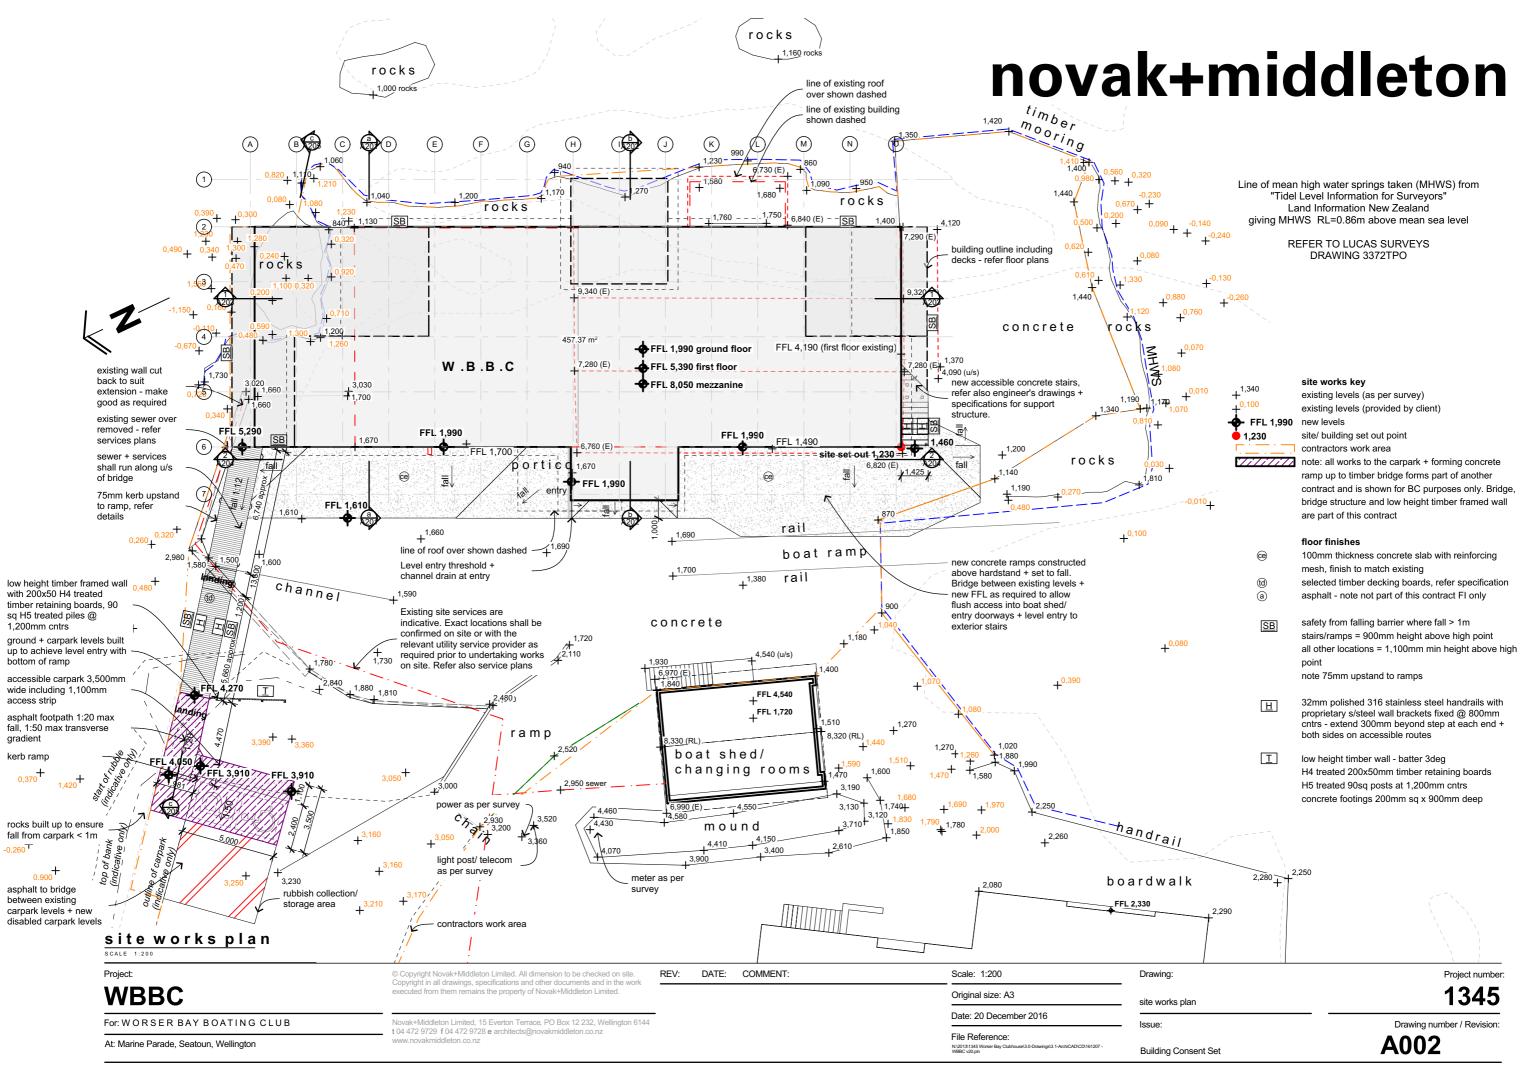

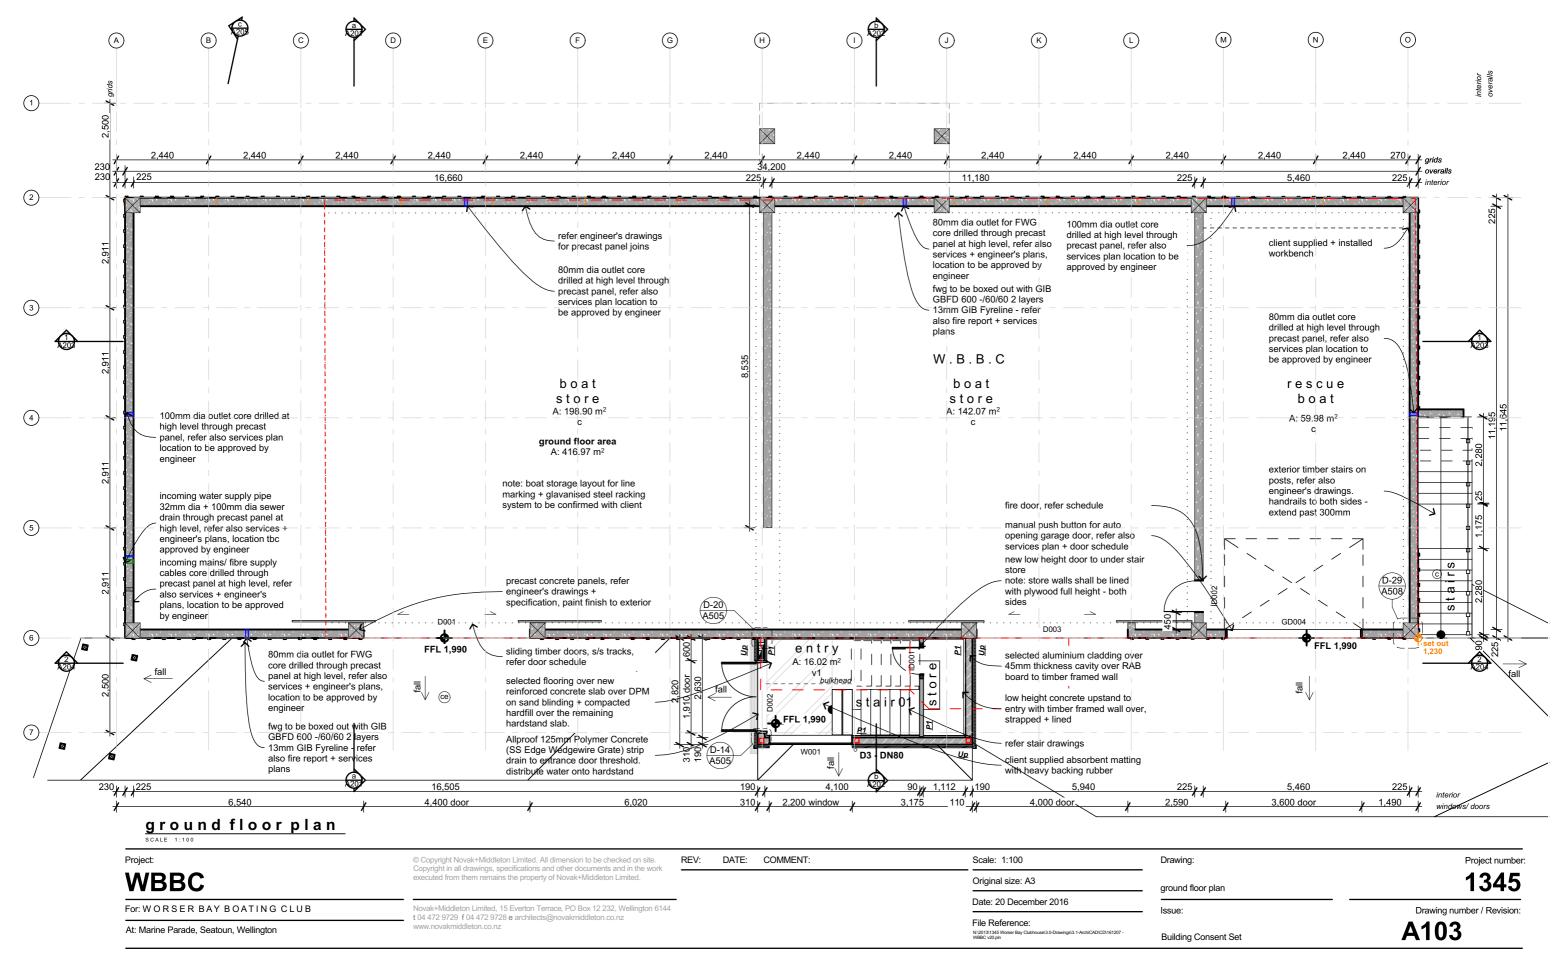

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WBBC	executed from them remains the property of Novak+Middleton Limited.				Original size: A3	first floor plan
r: WORSER BAY BOATING CLUB Novak+Middleton Limited, 15 Everton Terrace, PO Box 12 232, Wellington 6144		-			Date: 20 December 2016	Issue:
At: Marine Parade, Seatoun, Wellington	t 04 472 9729 f 04 472 9728 e architects@novakmiddleton.co.nz www.novakmiddleton.co.nz				File Reference: N\00131345 Worser Bay Clubhousel\3.0-Drawingsl\3.1-Arch/CAD/CD161207 - WBBC v20 pin	Building Con

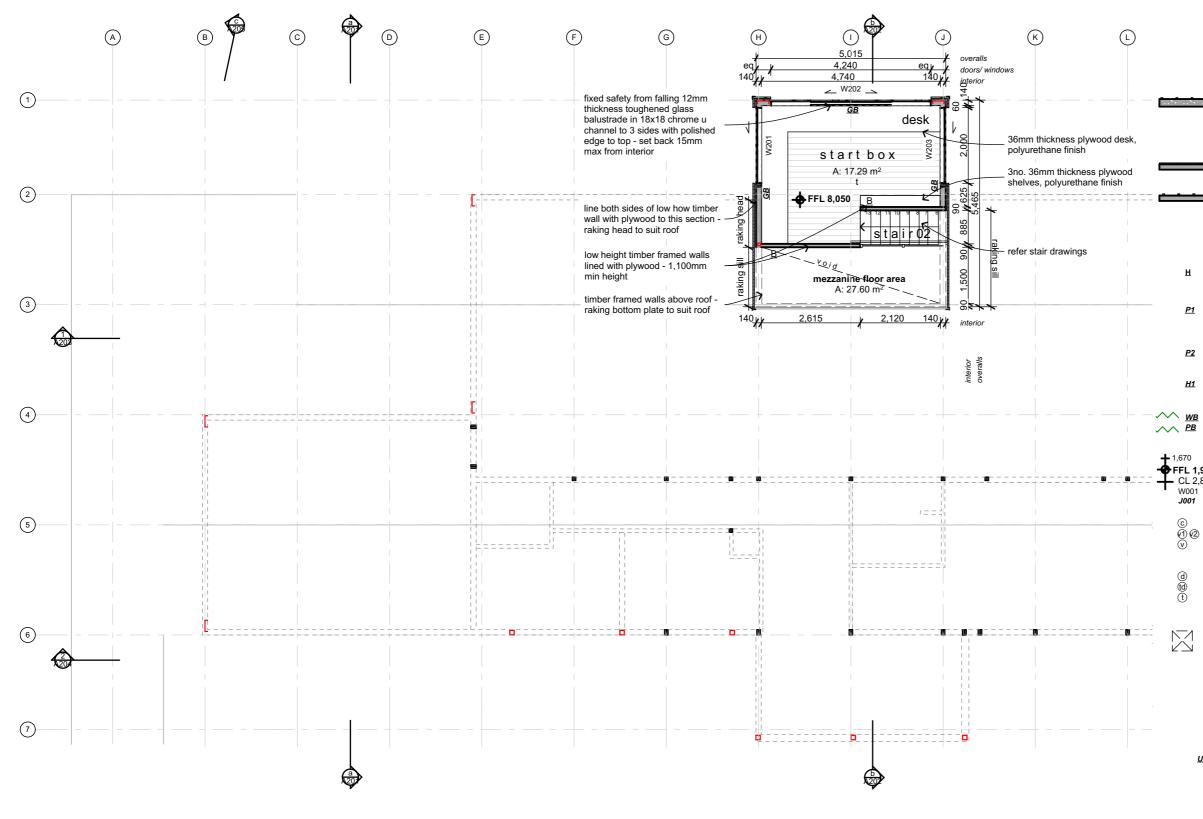

mezzanine floor plan SCALE 1:100

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For: WORSER BAY BOATING CLUB Novak+Middleton Limited, 15 Everton Terrace, PO Box 12 232, Wellington 6144 t 04 472 9729 f 04 472 9728 e architects@novakmiddleton.co.nz At: Marine Parade, Seatoun, Wellington www.novakmiddleton.co.nz		-			Date: 20 December 2016	Issue:
					File Reference: N100131345 Worser Bay Clubhousei3.0-Drawingei3.1-ArchiCADI/CD161207- WBBC v20 pin	Building Cor

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floor	pla	n key

	walls external timber framed walls shall be SG8 140/190mm thickness H3.2 treated kiln dried timber framing with H3.2 top and bottom plates. Dwangs @ 800mm. Refer also bracing plan. Internal timber framed walls to be SG8 140/90mm thickness H1.2 treated kiln dried timber framing with H3.2 top and bottom plates. Dwangs @ 800mm. Strapping shall be 45x45mm H1.2 treated kiln dried battens
- Tyl	concrete wall panels with surface pattern, paint finish exterior only. Provide 316 stainless steel staging scaffold sockets embedded in panels for future painter brackets (horizontally spaced 1.6m max apart - 3no. vertically evenly spaced) to Seaward facing panels (refer also North + East Elevations)
	wall cladding Colorcote AlumiGard corrugated wall cladding over 45mm thickness timber girts over 6mm thickness JH Home RAB board. s/s fixings.
ڪ	JH 9mm thickness Titan and Hardies CLD exposed vertical battens @ 400mm cntrs over 70x19mm CLD structural cavity battens @ 400mm cntrs + 6mm JH Home RAB board. (<i>Note: allow extra cost to sand the</i> <i>edges of CLD battens for smooth finish prior to using as external</i> <i>cladding batten</i>). Paint finish. s/s fixings
l	32mm polished 316 stainless steel handrails with proprietary s/steel wall brackets.
<u>91</u>	interior linings wall linings shall be 12mm Ecoply Plygroove to dado height 1,200mm, intumescent clear coat, 10mm GIB above dado to walls + 13mm GIB to suspended ceilings unless otherwise noted - paint finish. Refer also bracing plans.
2	wall linings to wet areas shall be 12mm plywood to dado height 1,200mm, intumescent clear coat, 10mm GIB aqualine lining above dado +13mm GIB aqualine suspended ceilings, paint finish.
11	HardiGlaze Premium 6mm thickness lining to walls + ceilings to kitchen area - aluminium jointers. Refer also specification for installation details + selections
<u>VB</u> 2 <u>B</u>	Whiteboard - in aluminium frame + steel backing, wall mounted Pinboard - autex vertiface panel or similar - colour tbc
0 1 ,990 2,850 01 01	general existing levels (as per survey) new levels (relative to site datum) ceiling level (above ffl) door/ window id - refer also door + window schedule
@ 1	floor finishes concrete float finish, refer specification selected vinyl over FLC, V1/V2 = alternating coluors, refer specification selected vinyl over FLC, refer specification 100mm high cove limited to bathroom + kitchen areas. Aluminium capping trim selected membrane, refer specification selected timber decking boards, refer specification selected timber flooring, refer specification note: ecoply flooring structural plywood shall be 17mm thickness T+G CD surface grade with sanded C face upwards, H3.2 treated, F8 stress grade New Rondo Panther ceiling access hatch 530x530mm.
-	note: - all steelwork/ reinforcing shall be galvanised prior to being erected on
Цр	site. - Flashings between wall cladding and concrete wall panels shall be 0.9mm aluminium pre painted with high build system - refer spec. - temporarily build up levels to build new building - refer also specification for selection of all materials + finishes - all timber framing shall be in accordance with NZS3604:2011 unless otherwise stated. - Form reinforced concrete upstand walls up to 50mm below window sill height to this section of the building - allow for line markings and numbering. Layout tbc - galv steel boat racks to Boat Shed. Allow for installation. Layout tbc - All concrete work to be ECS Marine II for externally exposed concrete with fly ash supplementary cementitious material (SCM). All other concrete shall be N30 with fly ash SCM - refer specification


ne floor plan

Project number:



Drawing number / Revision



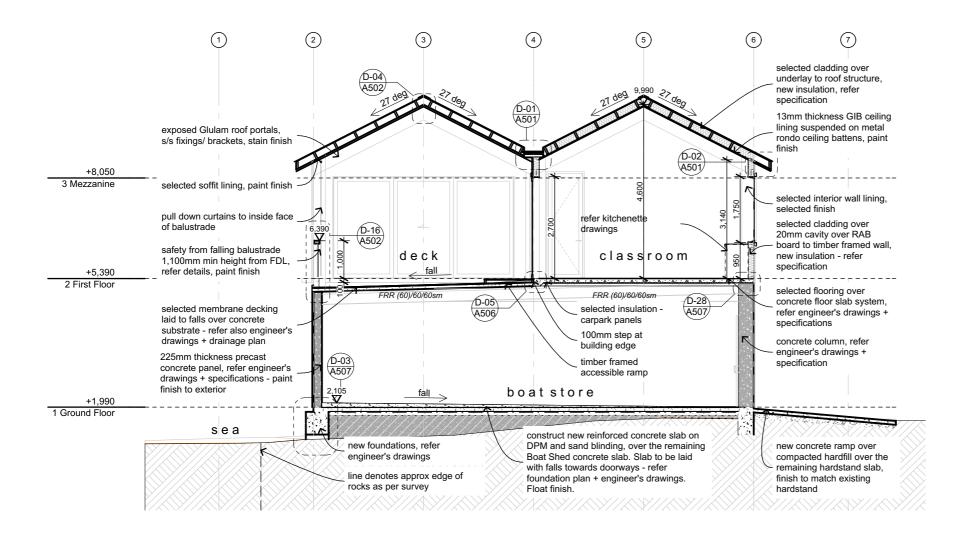

section a

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For: WORSER BAY BOATING CLUB	Novak+Middleton Limited, 15 Everton Terrace, PO Box 12 232, Wellington 6144	_			Date: 20 December 2016	Issue:
At: Marine Parade, Seatoun, Wellington	t 04 472 9729 f 04 472 9728 e architects@novakmiddleton.co.nz www.novakmiddleton.co.nz				File Reference: Nt03131345 Worser Bay Clubhousel3.0-Drawingsl3.1-ArchiCADICD161207 - WBBC v20 pin	Building Co


Consent Set



Project number:

refer also engineer's drawings + specifications note: concrete floor diagramatic

1345

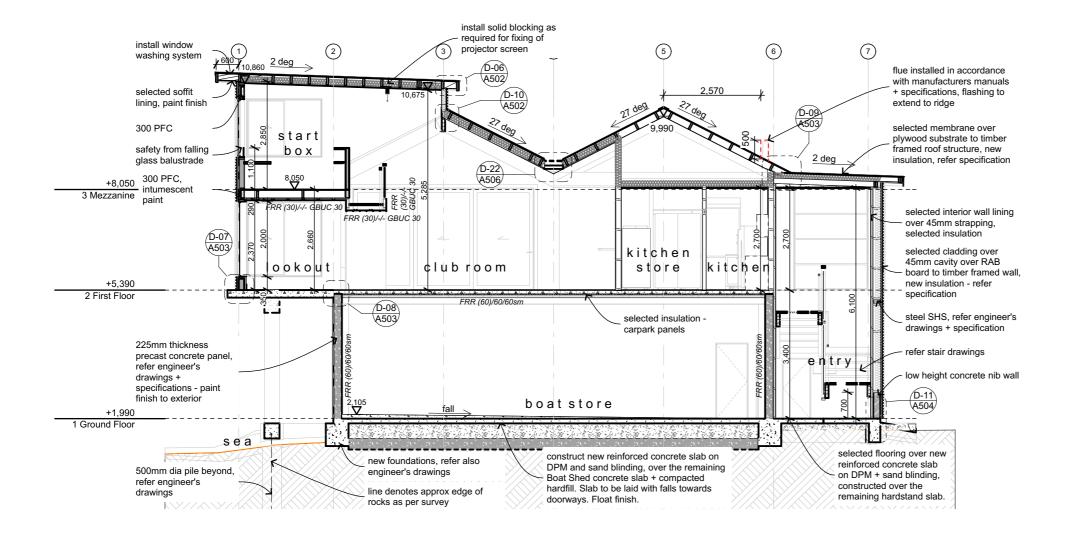

section b


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WBBC	executed from them remains the property of Novak+Middleton Limited.			Original size: A3	Original size: A3	section b
For: WORSER BAY BOATING CLUB	Novak+Middleton Limited, 15 Everton Terrace, PO Box 12 232, Wellington 6144	_			Date: 20 December 2016	Issue:
At: Marine Parade, Seatoun, Wellington	t 04 472 9729 f 04 472 9728 e architects@novakmiddleton.co.nz www.novakmiddleton.co.nz				File Reference: Nt20131345 Woser Bay Clubhousel3.0-Drawingsi3.1-Arch/CAD/CD161207 - WBBC v20 pin	Building Cor

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refer also engineer's drawings + specifications note: concrete floor diagramatic



Drawing number / Revision A202

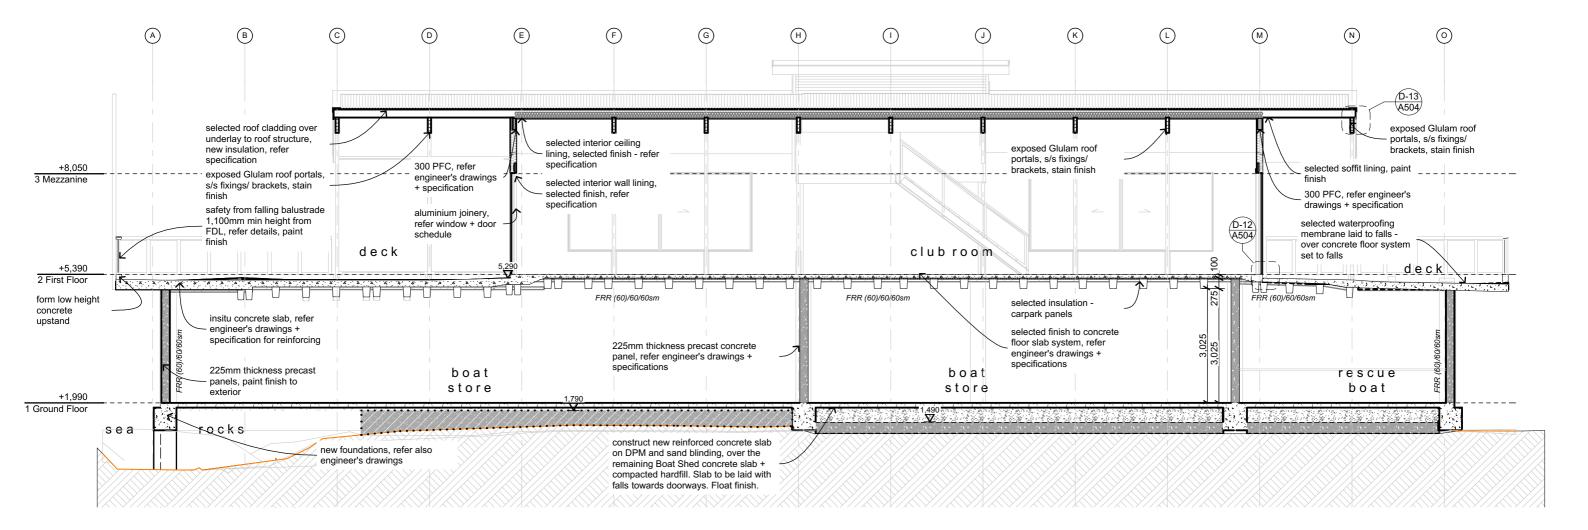

section 1 SCALE 1:100


Project:	© Copyright Novak+Middleton Limited. All dimension to be checked on site.	REV:	DATE:	COMMENT:	Scale: 1:100	Drawing:
WBBC	Copyright in all drawings, specifications and other documents and in the work executed from them remains the property of Novak+Middleton Limited.				Original size: A3	section 1
For: WORSER BAY BOATING CLUB	BAY BOATING CLUB Novak+Middleton Limited, 15 Everton Terrace, PO Box 12 232, Wellington 6144				Date: 20 December 2016	Issue:
Marine Parade, Seatoun, Wellington Wellington Novak+Mildaleton Limited, 15 EVertion Terrace, PO Box 12 232, Wellington 6144 t 04 472 9729 f 04 472 9728 e architects@novakmildaleton.co.nz www.novakmildaleton.co.nz					File Reference: N00113145 Worse Bay Clubhourel 3.0-Drawingsi 3.1-ArchiCADICD161207 - WBIC 2020 m	Building Con

refer also engineer's drawings + specifications note: concrete floor diagramatic



Drawing number / Revision

A203

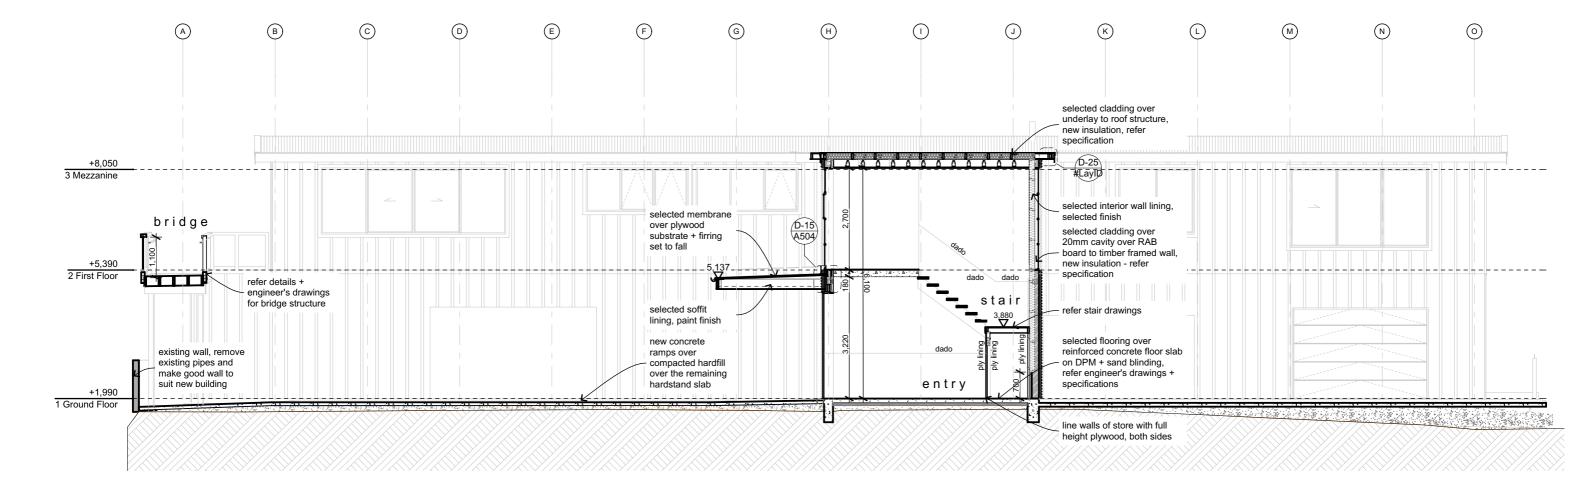

section 2

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For: WORSER BAY BOATING CLUB Novak+Middleton Limited, 15 Everton Terrace, PO Box 12 232, Wellington 6144		-			Date: 20 December 2016	Issue:
At: Marine Parade, Seatoun, Wellington	t 04 472 9729 f 04 472 9728 e architects@novakmiddleton.co.nz www.novakmiddleton.co.nz				File Reference: N 00151345 Worre Bay Clubhourel 3.0-Drawingst 3.1-ArchiCADICD161297 - WBSC 420.ph	Building Co


refer also engineer's drawings + specifications note: concrete floor diagramatic


A204



Drawing number / Revision:

2

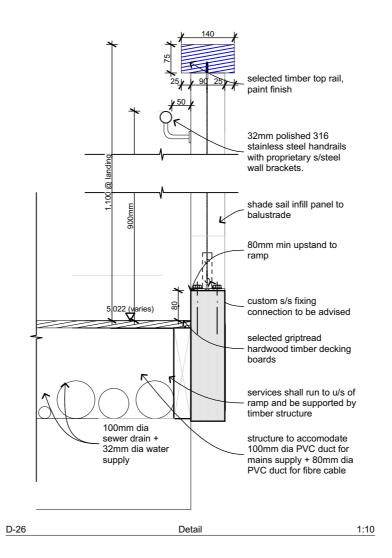

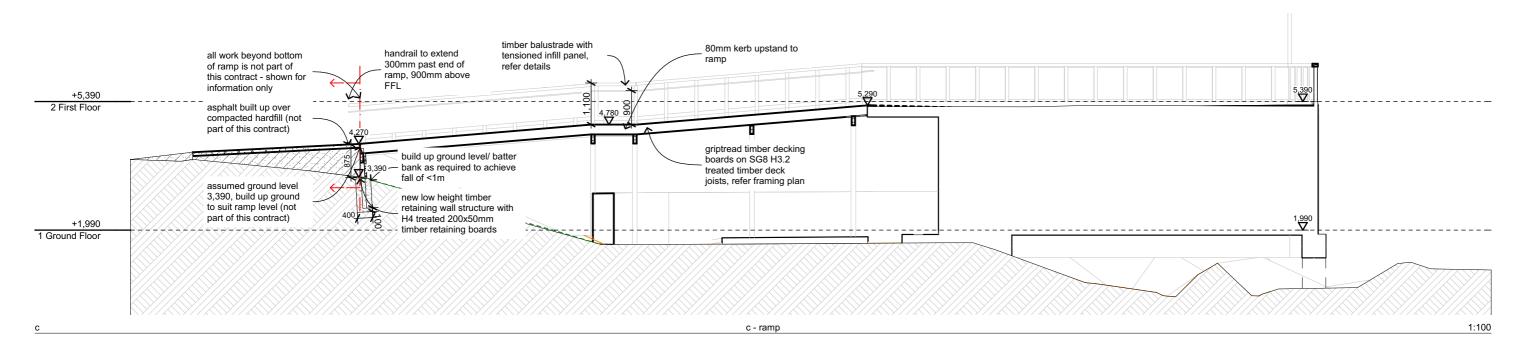


section c

© Copyright Novak+Middleton Limited. All dimension to be checked on site.	REV:	DATE:	COMMENT:	Scale: 1:100, 1:10	Drawing:	
executed from them remains the property of Novak+Middleton Limited.				Original size: A3	Original size: A3	ramp/ bridge
	-			Date: 20 December 2016	- Issue:	
t 04 472 9729 f 04 472 9728 e architects@novakmiddleton.co.nz www.novakmiddleton.co.nz				File Reference: N1031131145 Worser Bay Clubhousel3.0-Drawingsl3.1-Arch/CAD/CD161207 - WBBC v20.ph	Building Co	
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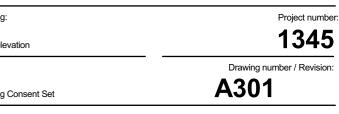
g: Project number: pridge structure 1345 Drawing number / Revision: g Consent Set A205


note: line upper level battens through with concrete panel extrusions below. Allow to set out studs, battens + sheets to suit on site



north elevation SCALE 1:100
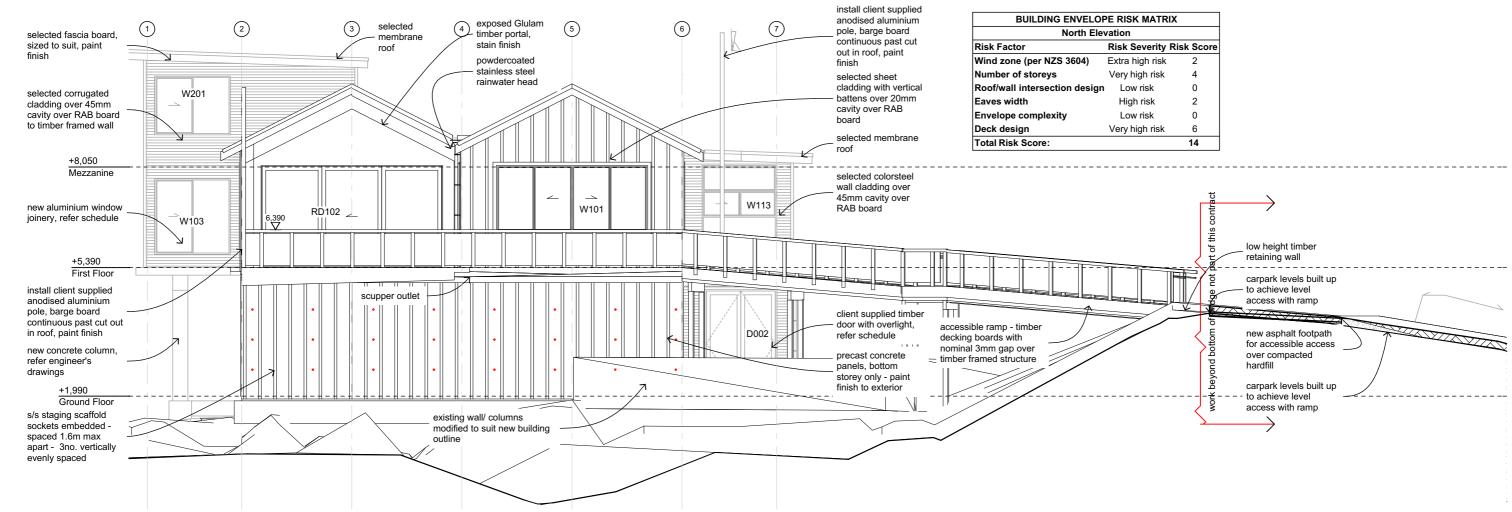
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	executed from them remains the property of Novak+Middleton Limited.				Original size: A3	north eleva
For: WORSER BAY BOATING CLUB Novak+Middleton Limited, 15 Everton Terrace, PO Box 12 232, Wellington 614					Date: 20 December 2016	- Issue:
At: Marine Parade, Seatoun, Wellington	t 04 472 9729 f 04 472 9728 e architects@novakmiddleton.co.nz				File Reference:	100001
					N1001311345 Worser Bay Clubhousel3.0-Drawingsl3.1-ArchiCAD/CD161207 - WBBC v20.pin	Building Co



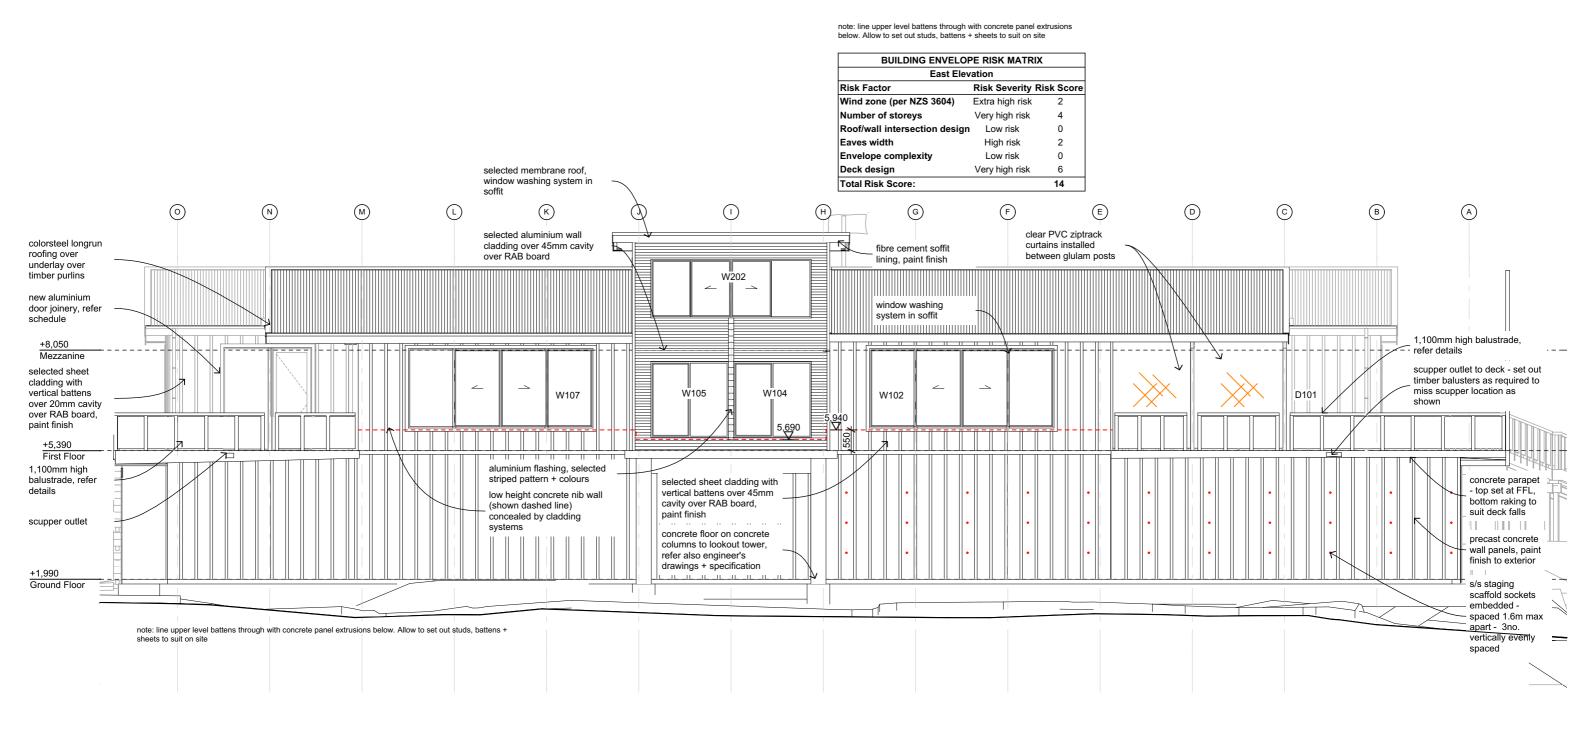


east elevation

SCALE 1:100



Drawing: Project number: east elevation 1345 Issue: Drawing number / Revision: Building Consent Set A302

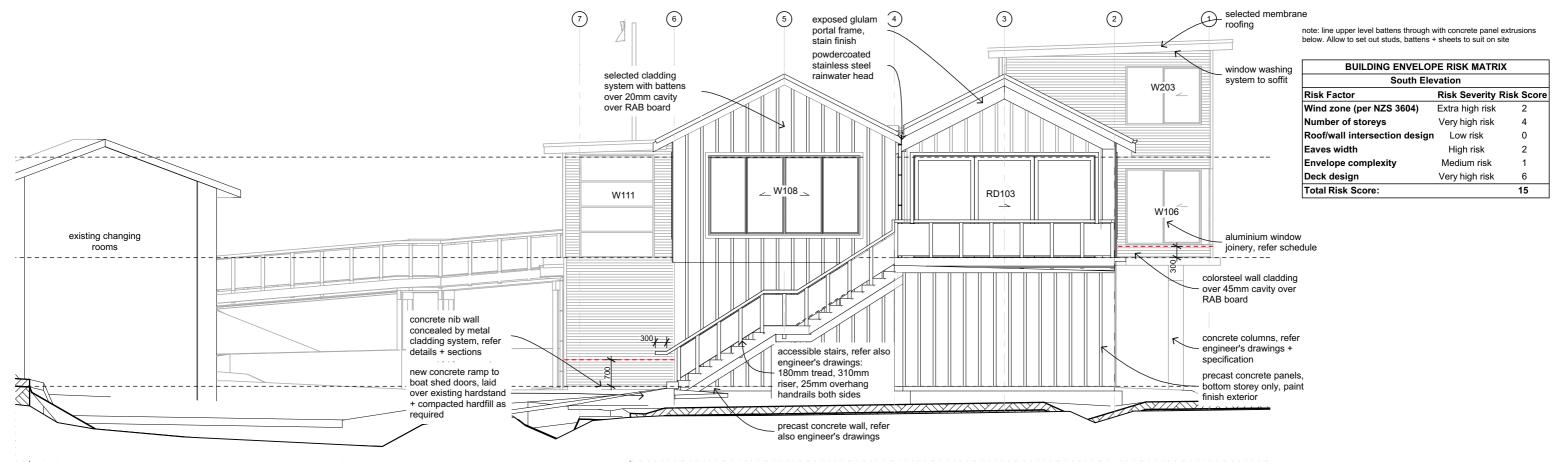

note: line upper level battens through with concrete panel extrusions below. Allow to set out studs, battens + sheets to suit on site

south elevation

SCALE 1:100

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For: WORSER BAY BOATING CLUB	Novak+Middleton Limited, 15 Everton Terrace, PO Box 12 232, Wellington 6144	-			Date: 20 December 2016	- Issue:
At: Marine Parade, Seatoun, Wellington	t 04 472 9729 f 04 472 9728 e architects@novakmiddleton.co.nz www.novakmiddleton.co.nz				File Reference: N20131345 Worser Bay Clubhousel3.0-Drawings13.1-Arch/CADICD161207 - WBBC v20.pln	Building Co


evation

Project number:



Drawing number / Revision

A303

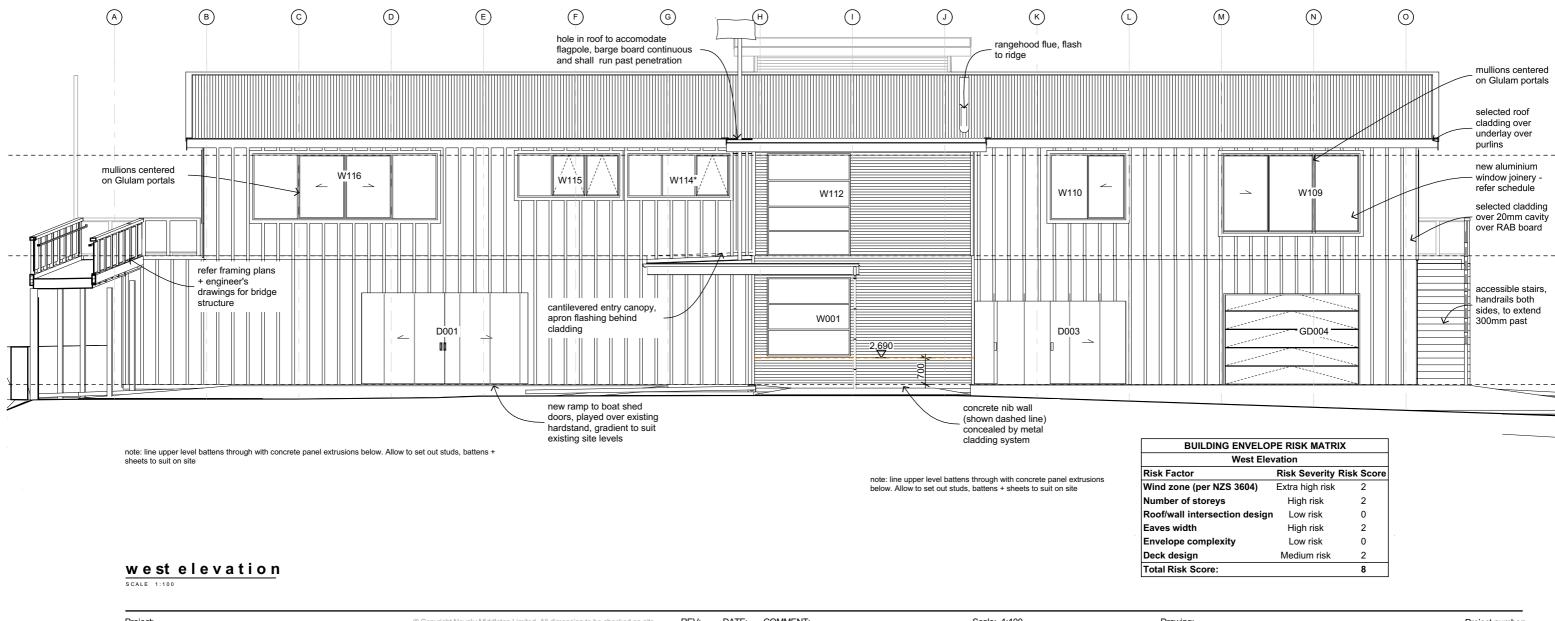

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At: Marine Parade, Seatoun, Wellington	t 04 472 9729 f 04 472 9728 e architects@novakmiddleton.co.nz www.novakmiddleton.co.nz				File Reference: N120131345 Woner Bay Clubhousei3.0-Drawingsi3.1-Arch/CADICD161207 - WBBC v20 pin	Building Cons

BUILDING ENVELOPE RISK MATRIX							
West Elevation							
or	Risk Severity	Risk Score					
e (per NZS 3604)	Extra high risk	2					
f storeys	High risk	2					
intersection design	Low risk	0					
th	High risk	2					
complexity	Low risk	0					
gn	Medium risk	2					
Score:		8					

tion

Project number:



Drawing number / Revision:

A304